



REPLY TO
ATTENTION OF:

Mississippi Branch
Regulatory Division

DEPARTMENT OF THE ARMY
CORPS OF ENGINEERS, MOBILE DISTRICT
P.O. BOX 2288
MOBILE, ALABAMA 36628-0001

September 24, 2019

**JOINT PUBLIC NOTICE SAM-2019-00241-JRO
U.S. ARMY CORPS OF ENGINEERS**

**MISSISSIPPI DEPARTMENT OF ENVIRONMENTAL QUALITY
OFFICE OF POLLUTION CONTROL**

**MISSISSIPPI DEPARTMENT OF MARINE RESOURCES
DMR-190225**

**REQUEST TO PLACE FILL IN WATERS OF THE U.S. TO CONSTRUCT A 26 ACRE
BENEFICIAL USE SITE FOR DREDGE MATERIAL IN
ST LOUIS BAY, HARRISON COUNTY, MISSISSIPPI**

TO WHOM IT MAY CONCERN:

This District has received an application for a Department of the Army permit pursuant to Section 10 of the River and Harbors Act of 1899 and Section 404 of the Clean Water Act. Please communicate this information to interested parties.

APPLICANT: **Mississippi Department of Marine Resources
Attention: Mr. Jared Harris, Beneficial Use Program
1141 Bayview Avenue
Biloxi, Mississippi 39530**

LOCATION: **In St. Louis Bay at the mouth of the Wolf River, near De Lisle, Harrison County, Mississippi. (Latitude 30.35734 North, Longitude -89.28755 West).**

WORK: **The applicant is requesting a 10-year permit to fill 26 acres of open water as a Beneficial Use (BU) for Dredged Material Disposal site at the mouth of the Wolf River. The proposed project would include an approximately 2,900 linear foot earthen berm and 1,600 linear foot rip rap containment berm. The earthen berm, would consist of sand material and be raised to an elevation of +4.5 feet MLLW. The rip rap berm would be raised to an elevation of +5.5 feet MLLW.**

Dredged material from various local dredging projects within Mississippi's three coastal Counties would be placed within the 26-acre bermed site over the 10-year period. All dredged material would be reviewed on a case-by-case basis for suitability of use within the BU site, through each individual permitting process. The site would accept material incrementally for the life of the permit or until capacity is reached. Depending on the composition of the material placed into the site, the anticipated capacity would be approximately 200,000 cubic yards.

EXISTING CONDITIONS: The site is located in St. Louis Bay at the mouth of the Wolf River. The site is within a shallow estuary containing an expansive salt marsh ecosystem. The substrate for the site is relatively smooth and featureless. The surface sediments have characteristics of muddy to silty sediments and composed of very soft clays.

PROJECT PURPOSE: As stated by the applicant, “The purpose of the project is the creation of 26 acres of coastal marsh habitat at the mouth of the Wolf River in St. Louis Bay.”

MITIGATION: The applicant has stated that compensatory mitigation would not be required for this project as the objective is to restore areas of degraded island habitat. Additional review of mitigation requirements will be performed by the USACE and cooperating agencies. Final compensatory mitigation will be evaluated by the USACE and cooperating resource agencies throughout the review process for the proposed project.

The applicant has applied for certification from the State of Mississippi in accordance with Section 401(a)(1) of the Clean Water Act and upon completion of the required advertising; a determination relative to certification will be made.

The applicant has applied for coastal zone consistency from the State of Mississippi Department of Marine Resources in accordance with Section 57-15-6 of the Mississippi Code Annotated. (DMR-190224).

This public notice is being distributed to all known interested persons in order to assist in developing facts on which a decision by the U.S. Army Corps of Engineers (USACE) can be based. For accuracy and completeness of the record, all data in support of or in opposition to the proposed work should be submitted in writing setting forth sufficient detail to furnish a clear understanding of the reasons for support or opposition.

The decision whether to issue a permit will be based on an evaluation of the probable impacts, including cumulative impacts, of the proposed activity on the public interest. That decision will reflect the national concern for both protection and utilization of important resources. The benefit which reasonably may be expected to accrue from the proposal must be balanced against its reasonably foreseeable detriments. All factors which may be relevant to the proposal will be considered, including the cumulative effects thereof; among those are conservation, economics, aesthetics, general environmental concerns, wetlands, historic properties, fish and wildlife values, flood hazards, floodplain values, land use, navigation, shoreline erosion and accretion, recreation, water supply and conservation, water quality, energy needs, safety, food and fiber production, mineral needs, consideration of property ownership and, in general, the needs and welfare of the people.

The USACE is soliciting comments from the public; Federal, State, and local agencies and officials; Indian tribes; and other interested parties in order to consider and evaluate the impacts of this proposed activity. Any comments received will be considered by the USACE to determine whether to issue, modify, condition or deny a permit for this proposal. To make this decision, comments are used to assess impacts on endangered species, historic properties, water quality, general environmental effects, and the other public interest factors listed above. Comments are used in the preparation of an Environmental Assessment and/or an Environmental Impact Statement pursuant to the National Environmental Policy Act. Comments are also used to determine the need for a public hearing and to determine the overall public interest of the proposed activity.

Any person may request in writing, within the comment period specified in this notice, that a public hearing be held to consider this application. Requests for public hearings shall state, with particularity, the reasons for holding a public hearing.

Evaluation of the probable impacts involving deposits of dredged or fill material into waters of the United States will include the application of guidelines established by the Administrator of the U.S. Environmental Protection Agency.

In accordance with Section 106 of the National Historic Preservation Act, and Appendix C of 33 CFR 325, the undertaking defined in this notice is being considered for the potential to effect cultural and historic properties within the permit area. In accordance with Appendix C of 33 CFR Part 325, the USACE has determined that the permit area is the full area of the project footprint. We are seeking comment from the State Historic Preservation Officer, federally-recognized American Indian tribes, local historical societies, museums, universities, the National Park Service, and the general public regarding the existence or the potential for existence of significant cultural and historic properties which may be affected by the work. The USACE has determined that the proposed project would have **no effect** on cultural resources in the permit area.

The 2017 Mississippi Standard Local Operating Procedures (SLOPES) for Endangered Species was utilized for the initial evaluation of proposed impacts to federally-listed species. Standard ESA Section 7(a)(2) procedures are followed for species not denoted by the SLOPES species-specific determination keys. A preliminary review of this application, of the U.S. Department of the Interior List of Endangered and Threatened Wildlife and Plants in the subject project's subwatershed, and the National Marine Fisheries Service list of Mississippi's Threatened and Endangered Species indicates the proposed project may affect but is not likely to adversely affect the West Indian manatee and Gulf sturgeon, and have no effect on any other threatened, endangered, or proposed species and/or their designated critical habitat. This notice serves as request to the U.S. Fish and Wildlife Service and National Marine Fisheries Service for information on whether any listed or proposed to be listed endangered or threatened species may be present in the area which would be affected by the proposed activity be affected by this project. This determination will be coordinated with the U.S. Fish and Wildlife Service and the National Marine Fisheries Service.


Correspondence concerning this Public Notice should refer to Public Notice Number **SAM-2019-00241-JRO** and should be directed to the District Engineer, Corps, Mobile District, Attention: **Mr. Jeremy Overstreet**, Post Office Box 2288, Mobile, Alabama 36628-0001, with a copy to the Mississippi Department of Environmental Quality, Office of Pollution Control, **Attention: Ms. Florance Bass, P.E.**, Post Office Box 2261, Jackson, Mississippi 39225 and the Mississippi Department of Marine Resources, **Attention: Mr. Chris Pickering**, 1141 Bayview Avenue, Suite 501, Biloxi, Mississippi 39530.

All comments should be received no later than 30 days from the date of this Public Notice. If you have any questions concerning this publication, you may contact the project manager, at (251) 690-3188 or email at jeremy.r.overstreet@usace.army.mil. Please refer to the above Public Notice number.

For additional information about our Regulatory Program, please visit our web site at: www.sam.usace.army.mil/Missions/Regulatory.aspx.

Encls

MOBILE DISTRICT
U.S. Army Corps of Engineers

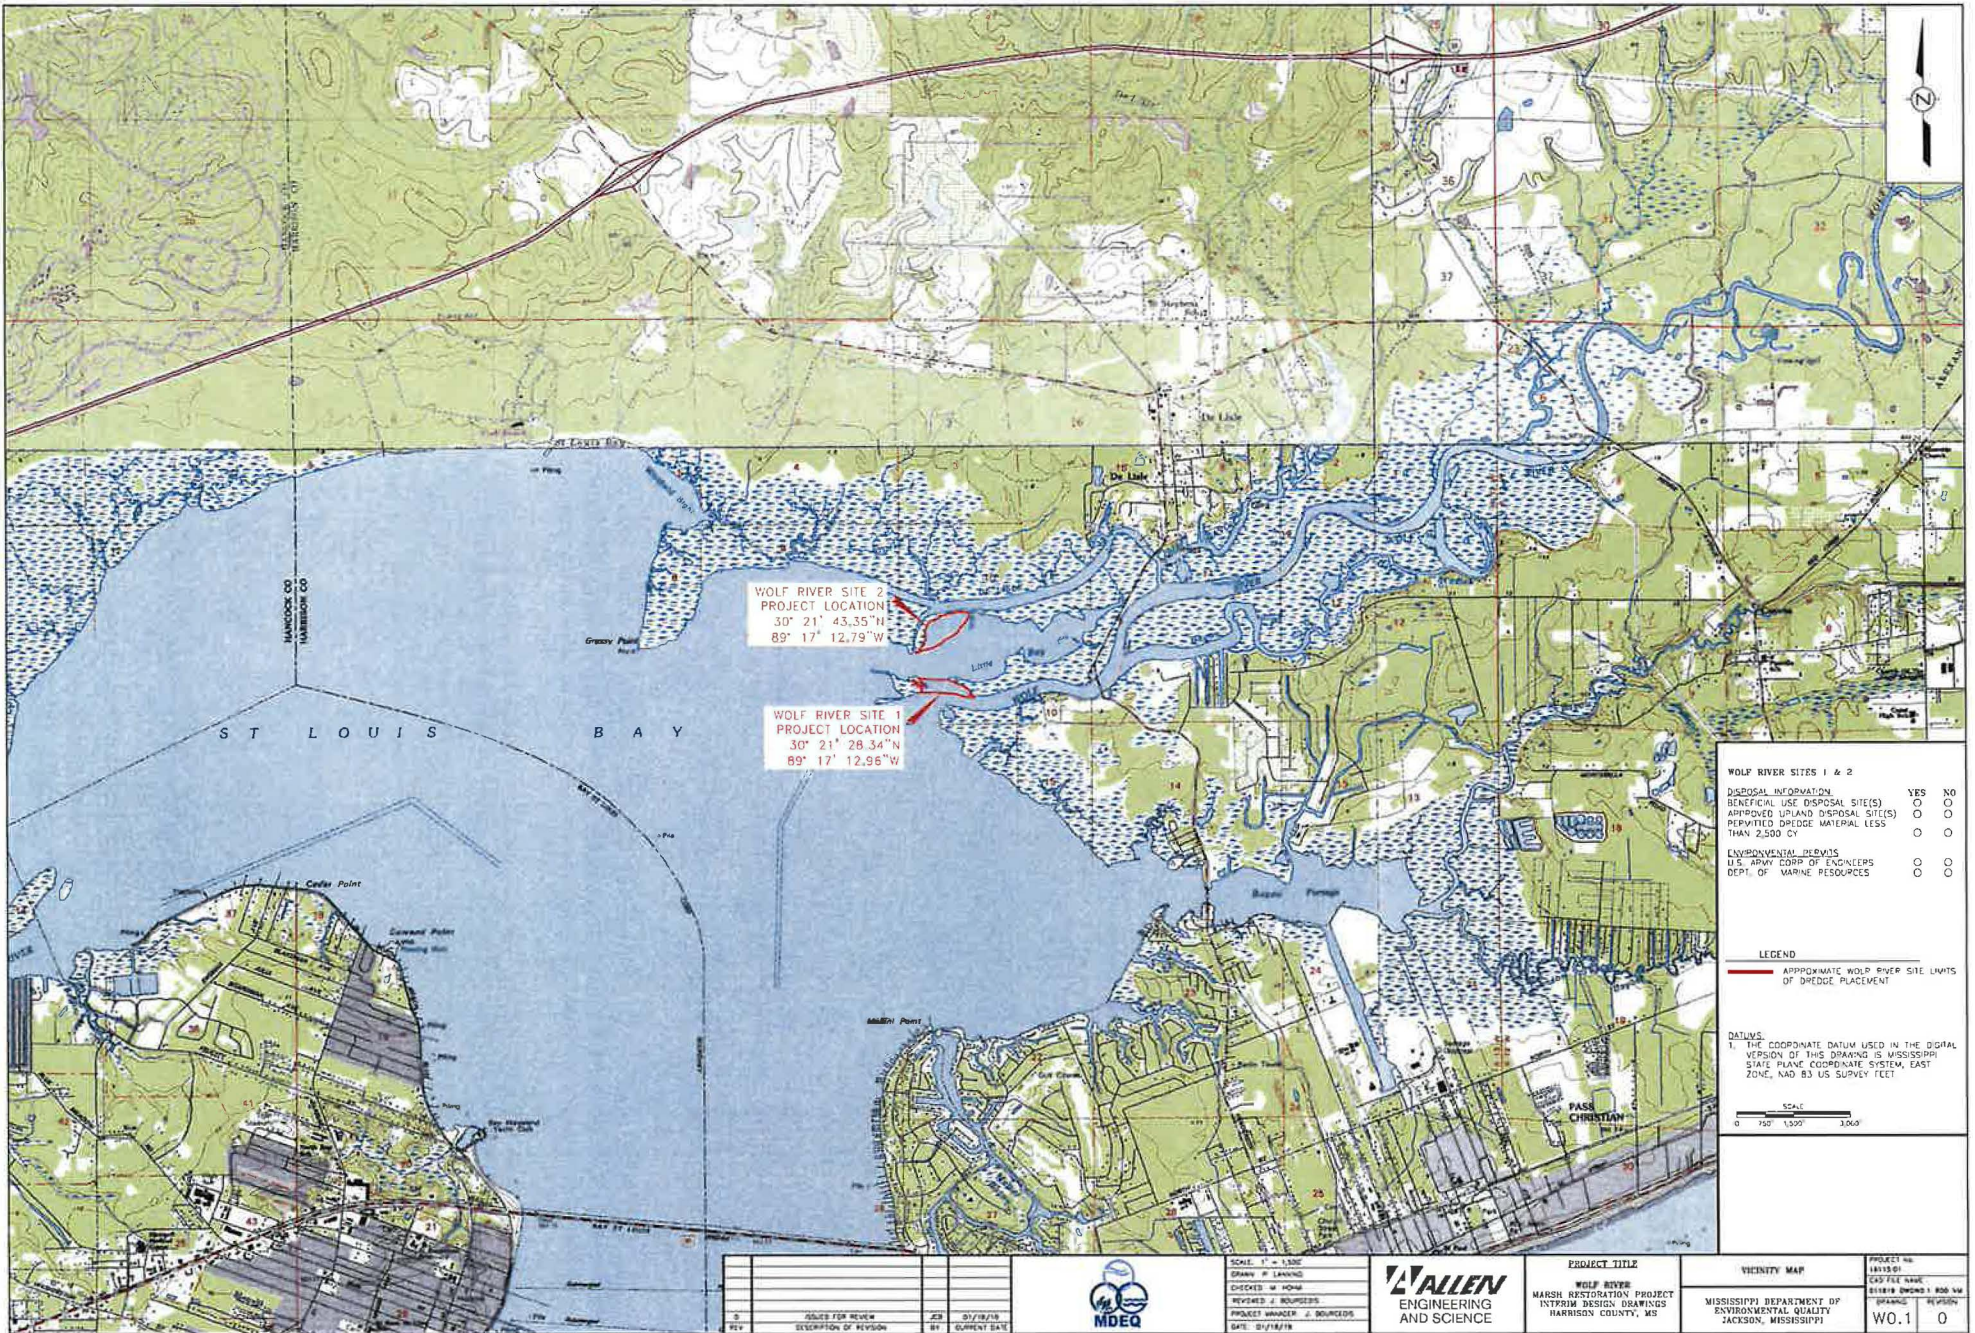

WOLF RIVER SITE 2
PROJECT LOCATION
30° 21' 43.35"N
89° 17' 12.79"W

WOLF RIVER SITE 1
PROJECT LOCATION
30° 21' 28.34"N
89° 17' 12.96"W

WOLF RIVER SITES 1 & 2

DISPOSAL INFORMATION	YES	NO
BENEFICIAL USE DISPOSAL SITES	<input type="checkbox"/>	<input type="checkbox"/>
APPROXIMATE USLAND DISPOSAL SITES	<input type="checkbox"/>	<input type="checkbox"/>
PERMITTED DREDGE MATERIAL LESS THAN 2,500 CY	<input type="checkbox"/>	<input type="checkbox"/>
ENVIRONMENTAL DEVIATIONS		
U.S. ARMY CORP. OF ENGINEERS	<input type="checkbox"/>	<input type="checkbox"/>
DEPT. OF MARINE RESOURCES	<input type="checkbox"/>	<input type="checkbox"/>

LEGEND

— APPROXIMATE WOLF RIVER SITE LIMITS OF DREDGE PLACEMENT

DATUMS

1. THE COORDINATE DATUM USED IN THE DIGITAL VERSION OF THIS DRAWING IS MISSISSIPPI STATE PLANE COORDINATE SYSTEM, EAST ZONE, NAD 83 US SURVEY FEET



NO. 1	DESIGN FOR REVIEW	JEB	01/18/18
NO. 2	DESCRIPTION OF REVISION	BT	CURRENT DATE



SCALE: 1" = 1,500'
 DRAWN BY: LANNING
 CHECKED BY: HOWE
 REVIEWED BY: BOURGESS
 PROJECT MANAGER: J. BOURGESS
 DATE: 01/18/18



PROJECT TITLE
 WOLF RIVER
 MARSH RESTORATION PROJECT
 INTERIM DESIGN DRAWINGS
 HARRISON COUNTY, MS

VICINITY MAP
 MISSISSIPPI DEPARTMENT OF
 ENVIRONMENTAL QUALITY
 JACKSON, MISSISSIPPI

PROJECT NO.	180130P
DRAWING NO.	01818 ENQMS I ROD V4
DATE	01/18/18
REVISION	0



Point No.	Northing	Easting	Comments
1	312071.21	840693.45	
2	312070.34	841152.53	
3	312036.05	841608.60	
4	311954.78	841907.11	
5	311930.97	842151.92	
6	312408.04	841424.82	
7	312448.72	840677.01	
8	312410.10	840522.09	
9	312368.78	840505.11	
10	313131.40	840560.97	
11	313051.28	840539.82	
12	313222.74	840964.46	
13	313309.00	841149.15	
14	313684.26	841240.10	
15	314174.95	842037.59	
16	314215.81	841924.96	

LEGEND

- APPROXIMATE WOLF RIVER SITE LIMITS OF DREDGE PLACEMENT
- - - APPROXIMATE WOLF RIVER SITE LIMITS OF DREDGE PLACEMENT
- - - APPROXIMATE 1" CONTOUR INTERVAL
- - - APPROXIMATE 0.5' CONTOUR INTERVAL

NOTES:

- BREACH CONTAINMENT BERM APPROXIMATELY 100' LONG AFTER COMPLETION OF DREDGE PLACEMENT



DATUMS:

- THE COORDINATE DATUM USED IN THE DIGITAL VERSION OF THIS DRAWING IS MISSISSIPPI STATE PLANE COORDINATE SYSTEM, EAST ZONE, NAD 83 US SURVEY FEET.
- THE VERTICAL DATUM FOR THIS DRAWING IS ORTHOMETRIC HEIGHTS, US SURVEY FEET, GEDD12AU7 NAVD83 AS DETERMINED BY RAPID STATIC GPS OBSERVATIONS PROCESSED THROUGH NCS'S OPUS SITE [WWW.NCS.NDAA.GOV/OPUS]

SCALE

0 50 100 200

	SCALE: 1" = 100' DRAWN: P. LANNING CHECKED: J. BOURGEOIS REVIEWED: J. BOURGEOIS PROJECT MANAGER: J. BOURGEOIS DATE: 01/18/18			PROJECT TITLE WOLF RIVER MARSH RESTORATION PROJECT INTERIM DESIGN DRAWINGS HARRISON COUNTY, MS	SITE PLAN	PROJECT NO. 10153 (P)
	MISSISSIPPI DEPARTMENT OF ENVIRONMENTAL QUALITY JACKSON, MISSISSIPPI			DRAWING: W1.2 REVISION: 0		

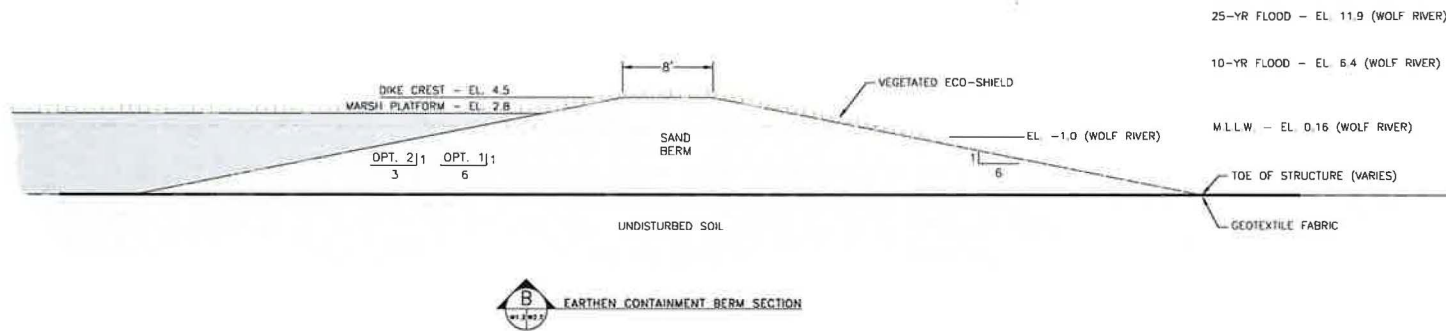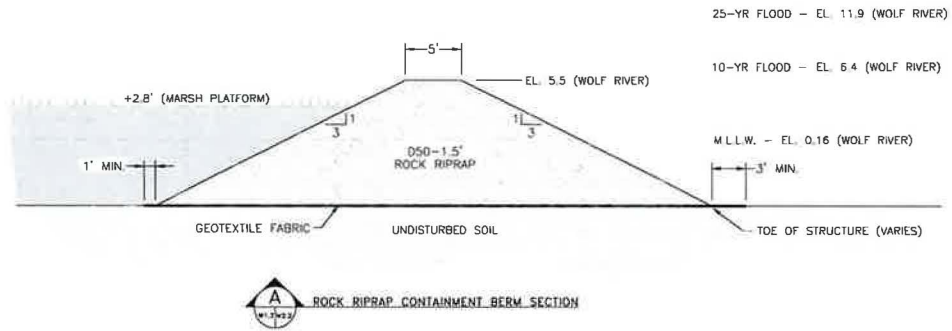

LEGEND

UNDISTURBED SOIL
 IN-SITU FILL
 LOOSE/SOFT MATERIAL

NOTES:

1. PROVIDE 20' CROWN WIDTH AT LOCATION OF DECANT PIPING. ADDITIONALLY, PROVIDE AND MAINTAIN 3' MINIMUM COVER OVER DECANT PIPING.
2. BREACH TIDAL CHANNEL CUTOFF BERM AFTER DREDGING OPERATIONS ARE COMPLETED TO RE-ESTABLISHED FLOW CONDITIONS
3. REFER TO PROJECT TECHNICAL SPECIFICATIONS FOR DETAILS

NO.	DATE FOR REVIEW	BY	DESCRIPTION OF REVISION



SCALE: NTS
 DRAWN: _____
 CHECKED: _____
 REVIEWED: _____
 PROJECT MANAGER / SUPERVISOR
 DATE: 01/18/19



PROJECT TITLE
 WOLF RIVER
 MARSH RESTORATION PROJECT
 INTERIM DESIGN DRAWINGS
 HARRISBORO COUNTY, MS

TYPICAL SECTIONS AND DETAILS
 MISSISSIPPI DEPARTMENT OF
 ENVIRONMENTAL QUALITY
 JACKSON, MISSISSIPPI

PROJECT NO. 18115.01	DWG FILE NAME BRRM18115.01.DWG
DRAWING REVISION	REVISION
W2.1	0